
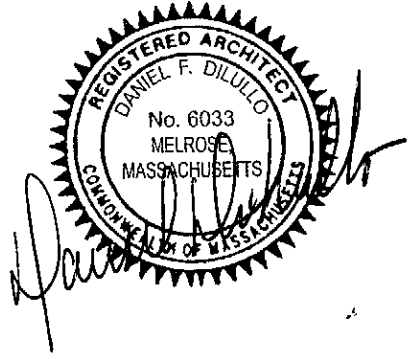


See Section C on A1.2 for proposed portable access ramps to be used a main ice surface entrance door.

dwg no:

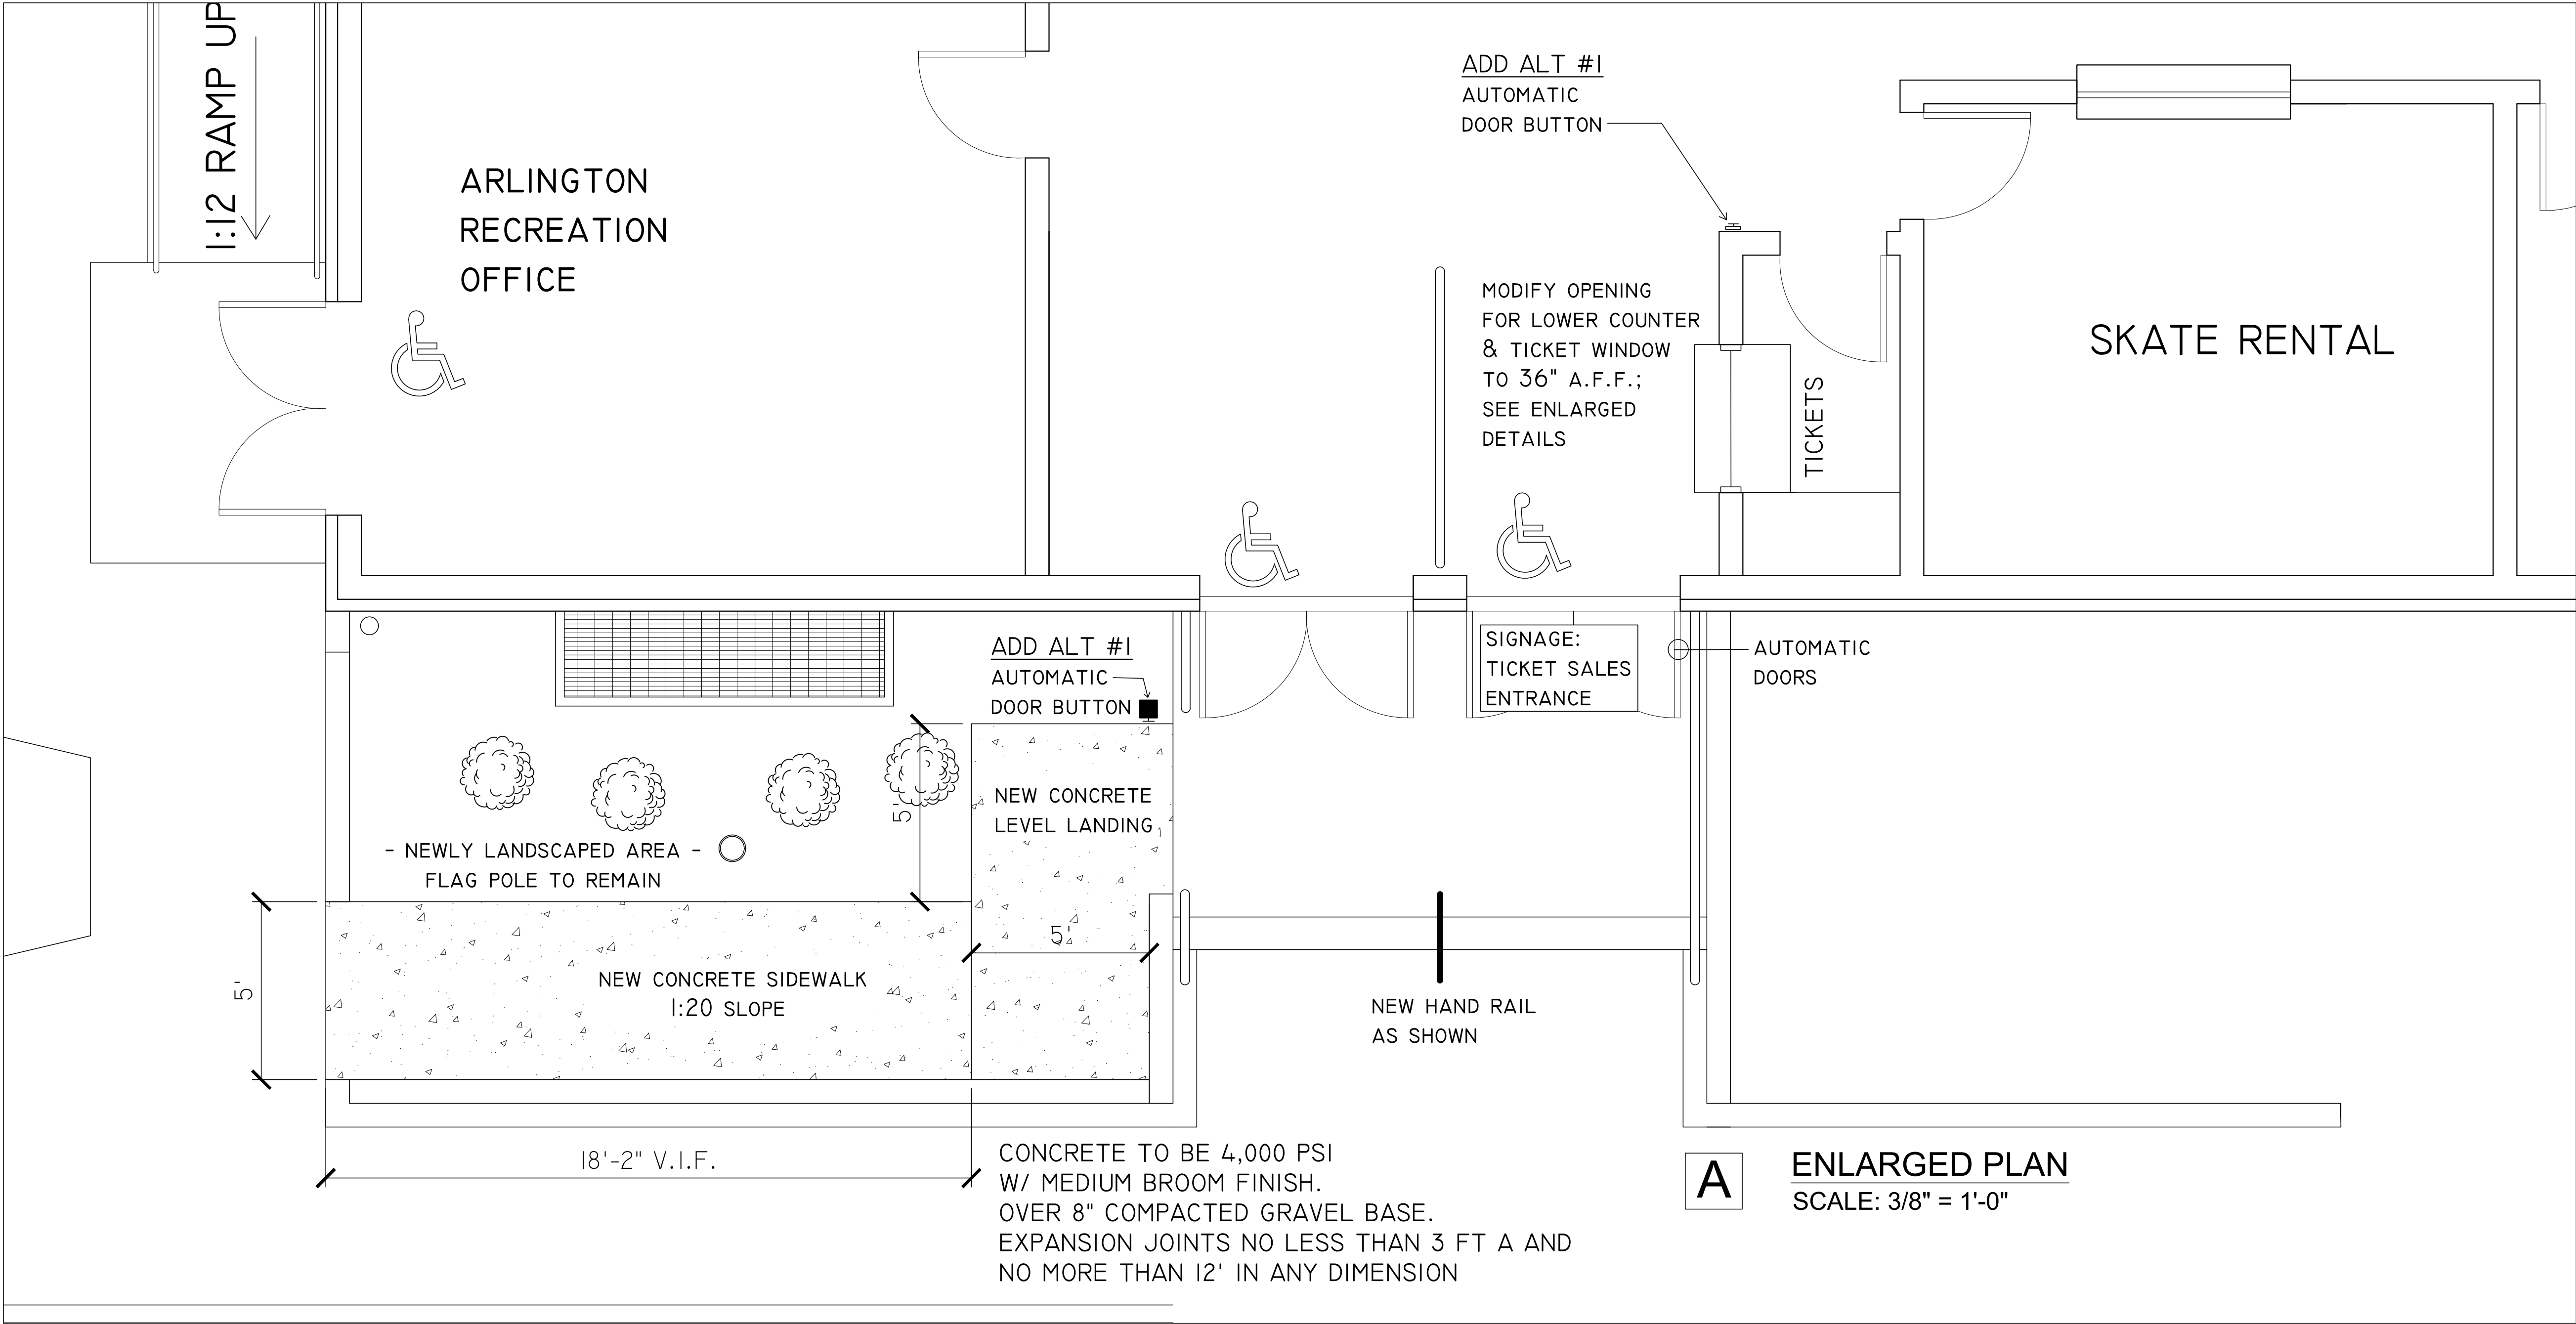

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**Ed Burns Arena
Accessibility Study**
422 Summer Street
Arlington Massachusetts

project:

drawing title:
ENLARGED PLAN

A1.1


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date: 6/24/19



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JPL


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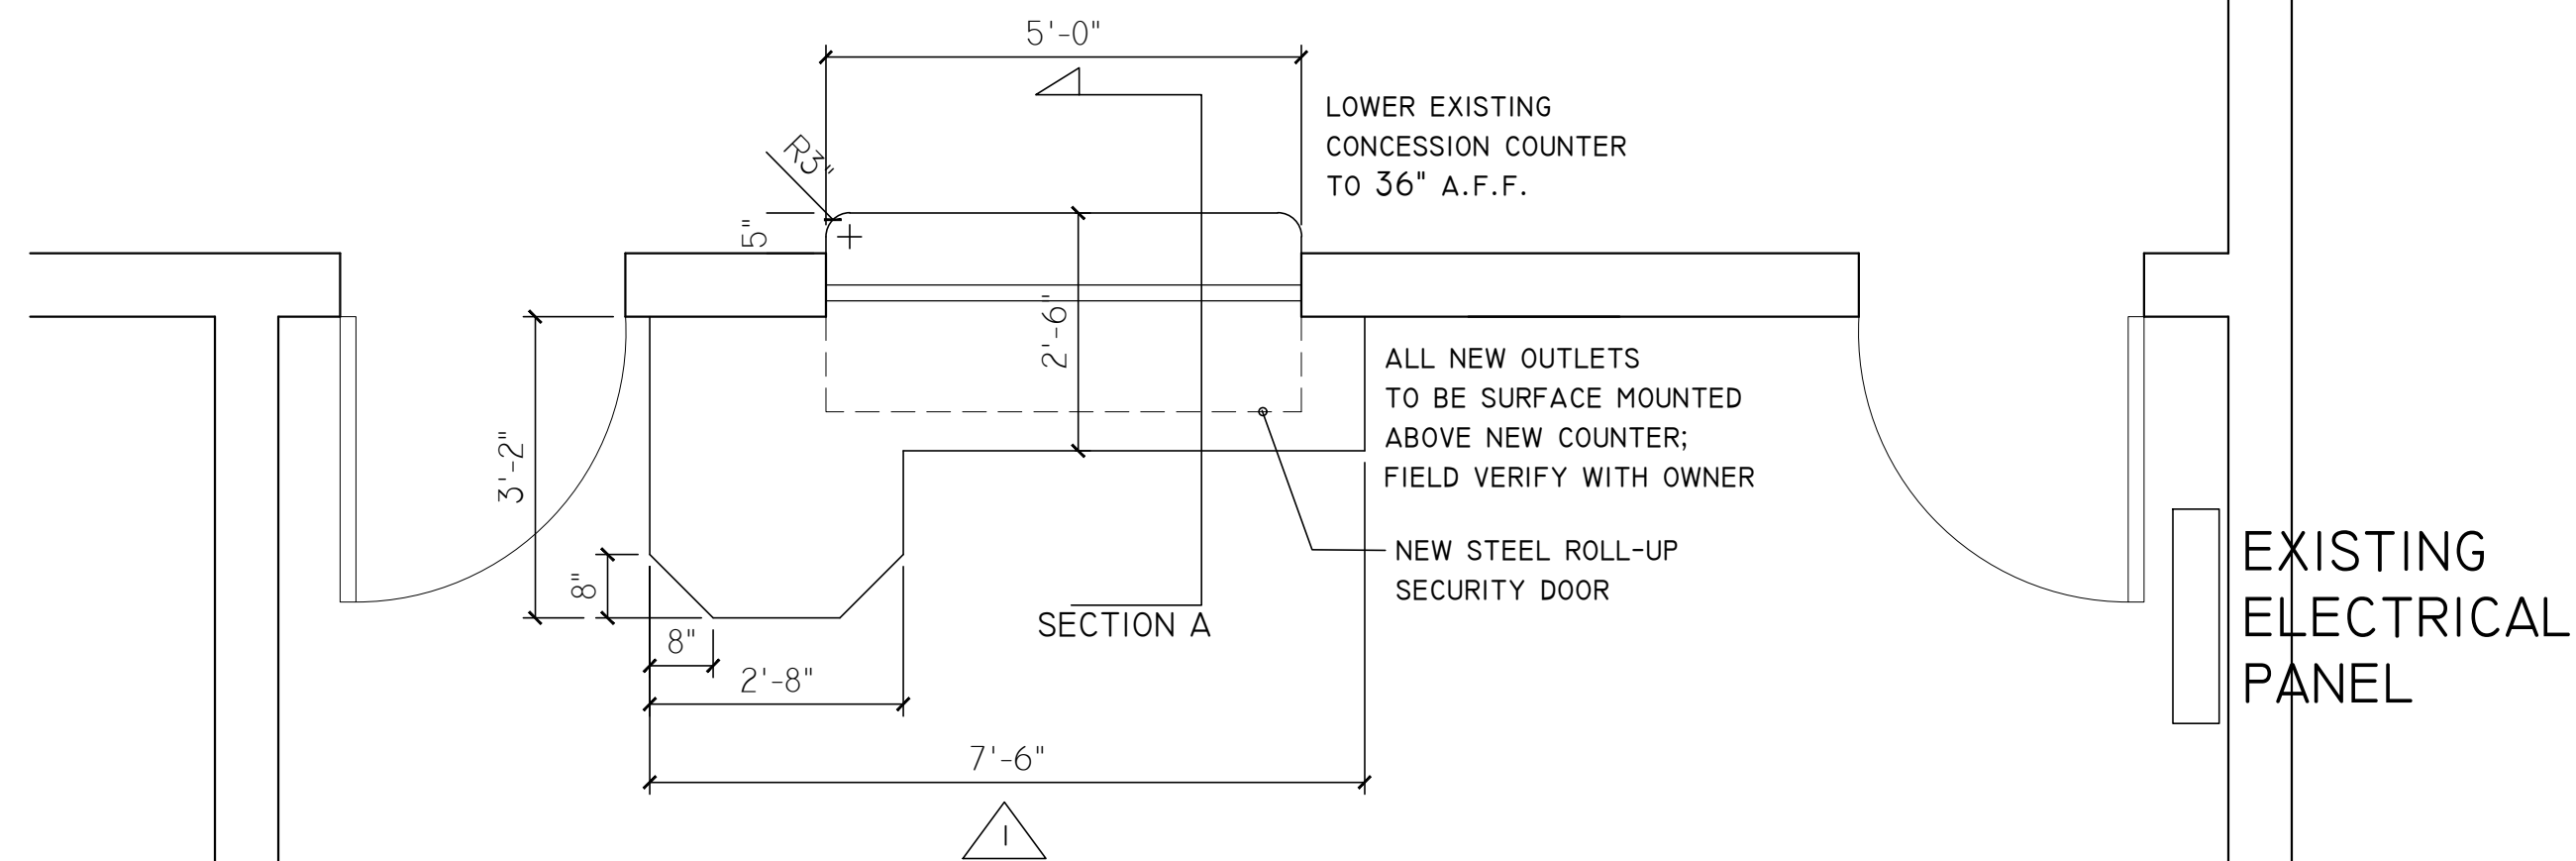
A **TICKET BOOTH COUNTER**
SCALE: $\frac{1}{2}$ " = 1'-0"




E **ACCESSIBLE ICE SURFACE ENTRY**
SCALE: 1" = 1'-0"


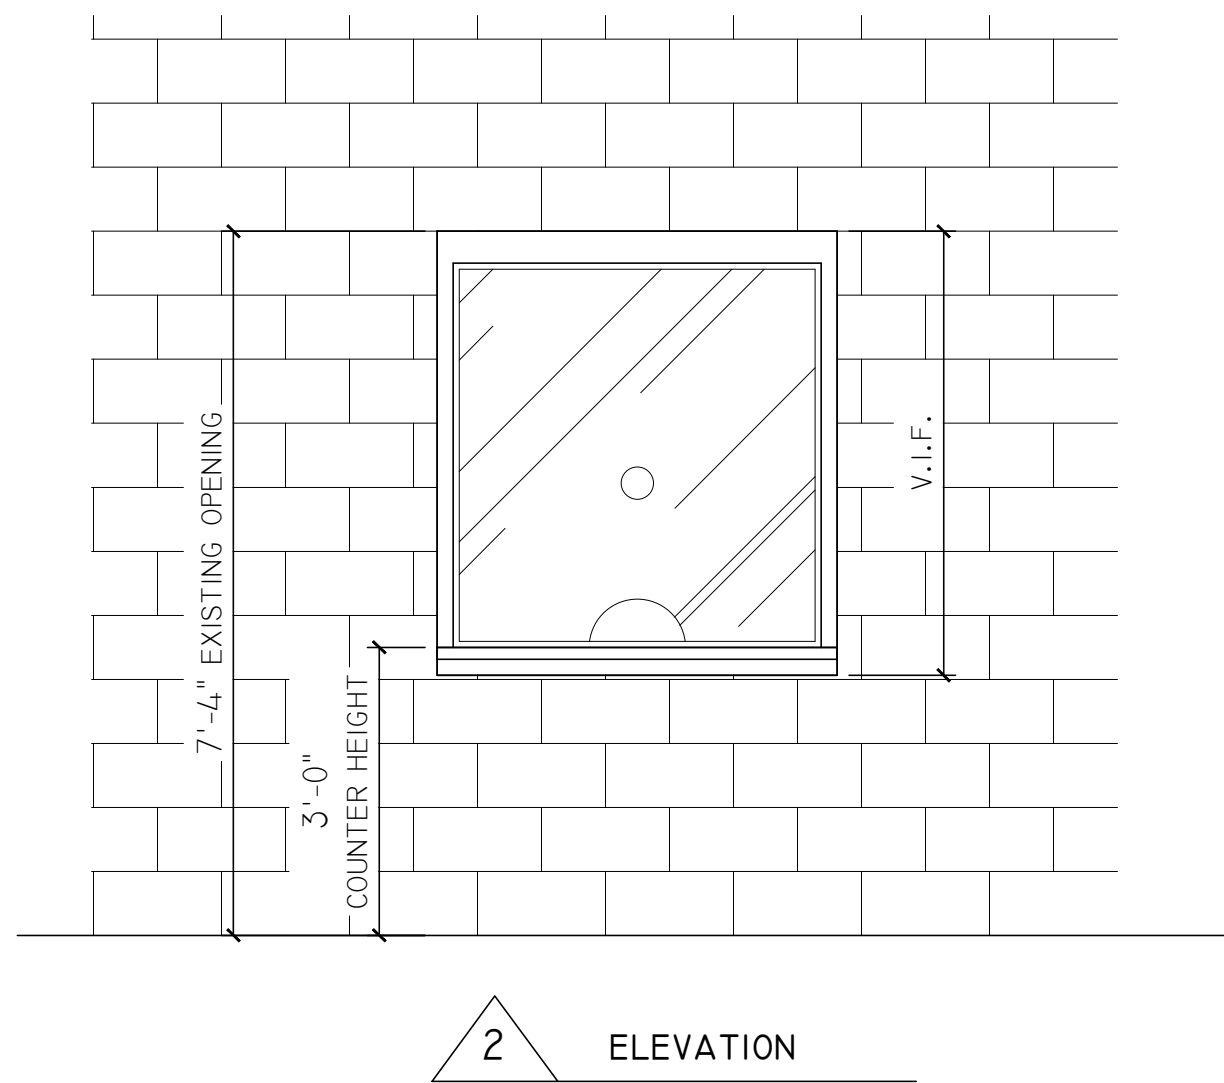


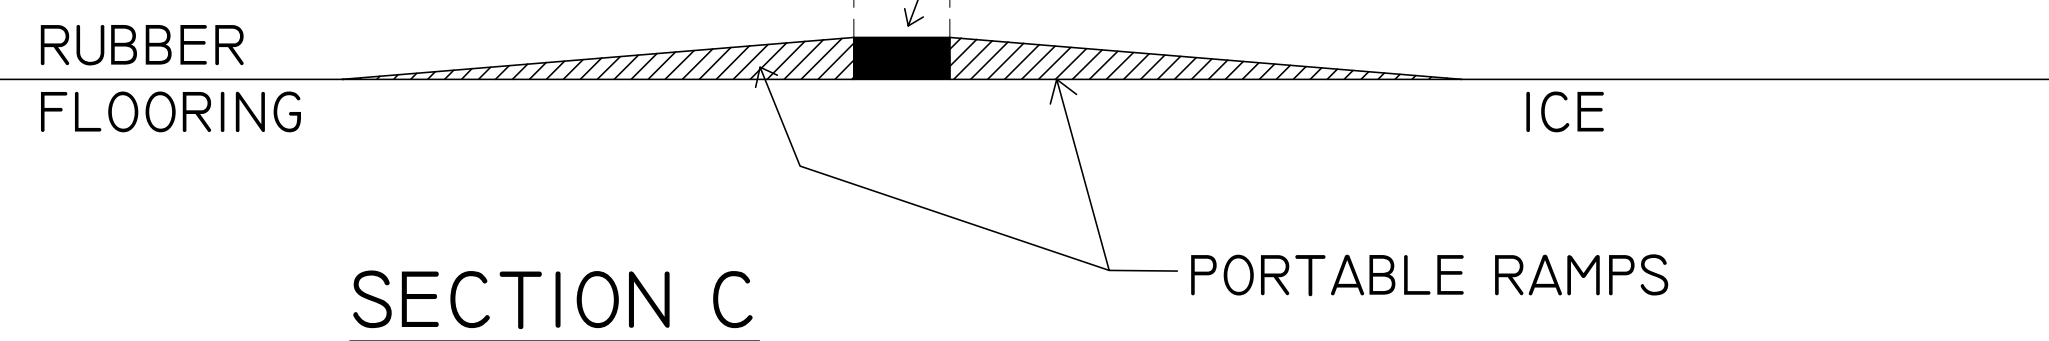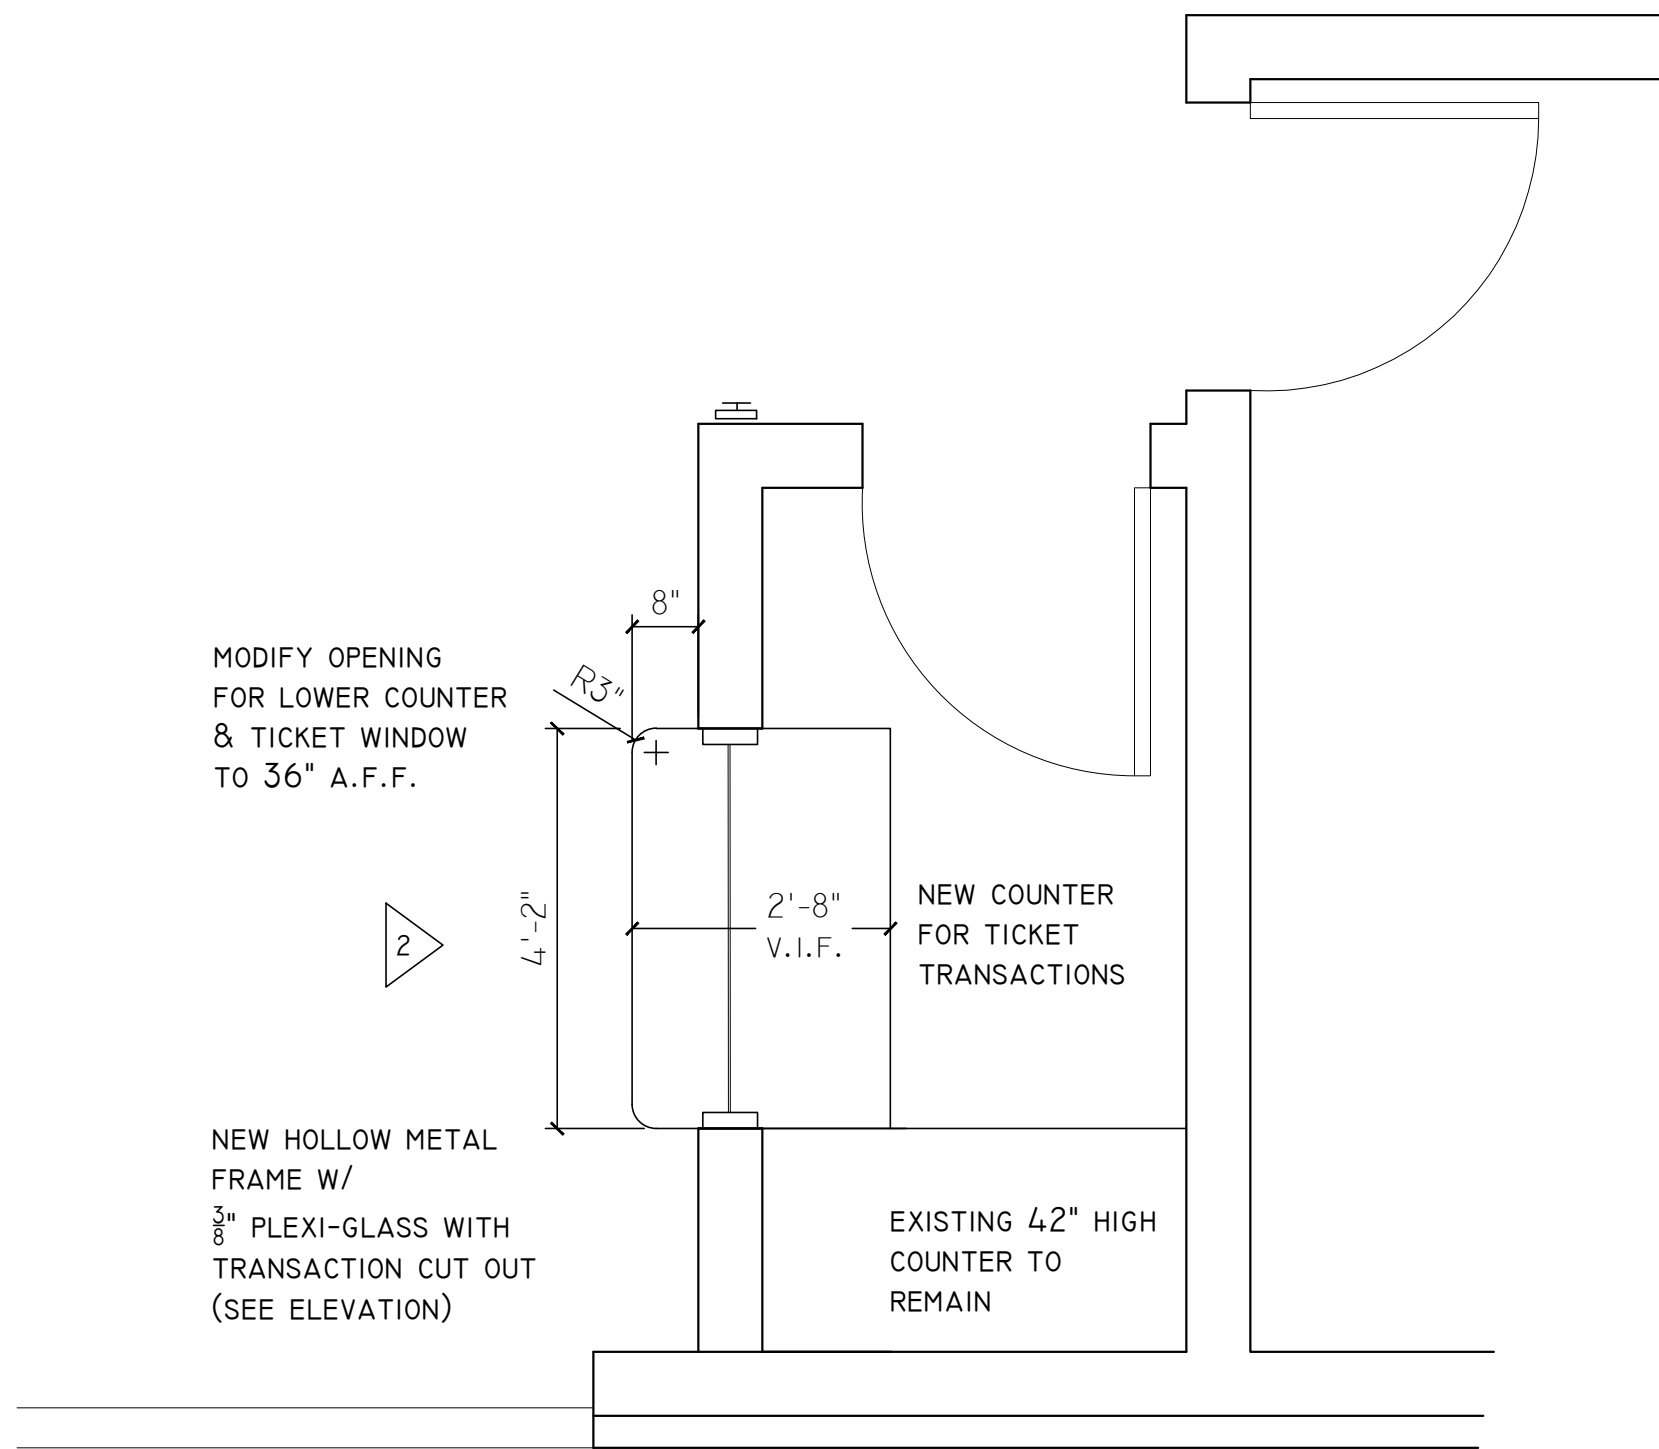
B **CONCESSION COUNTER SECTIONS & ELEVATION**
SCALE: $\frac{1}{2}$ " = 1'-0"

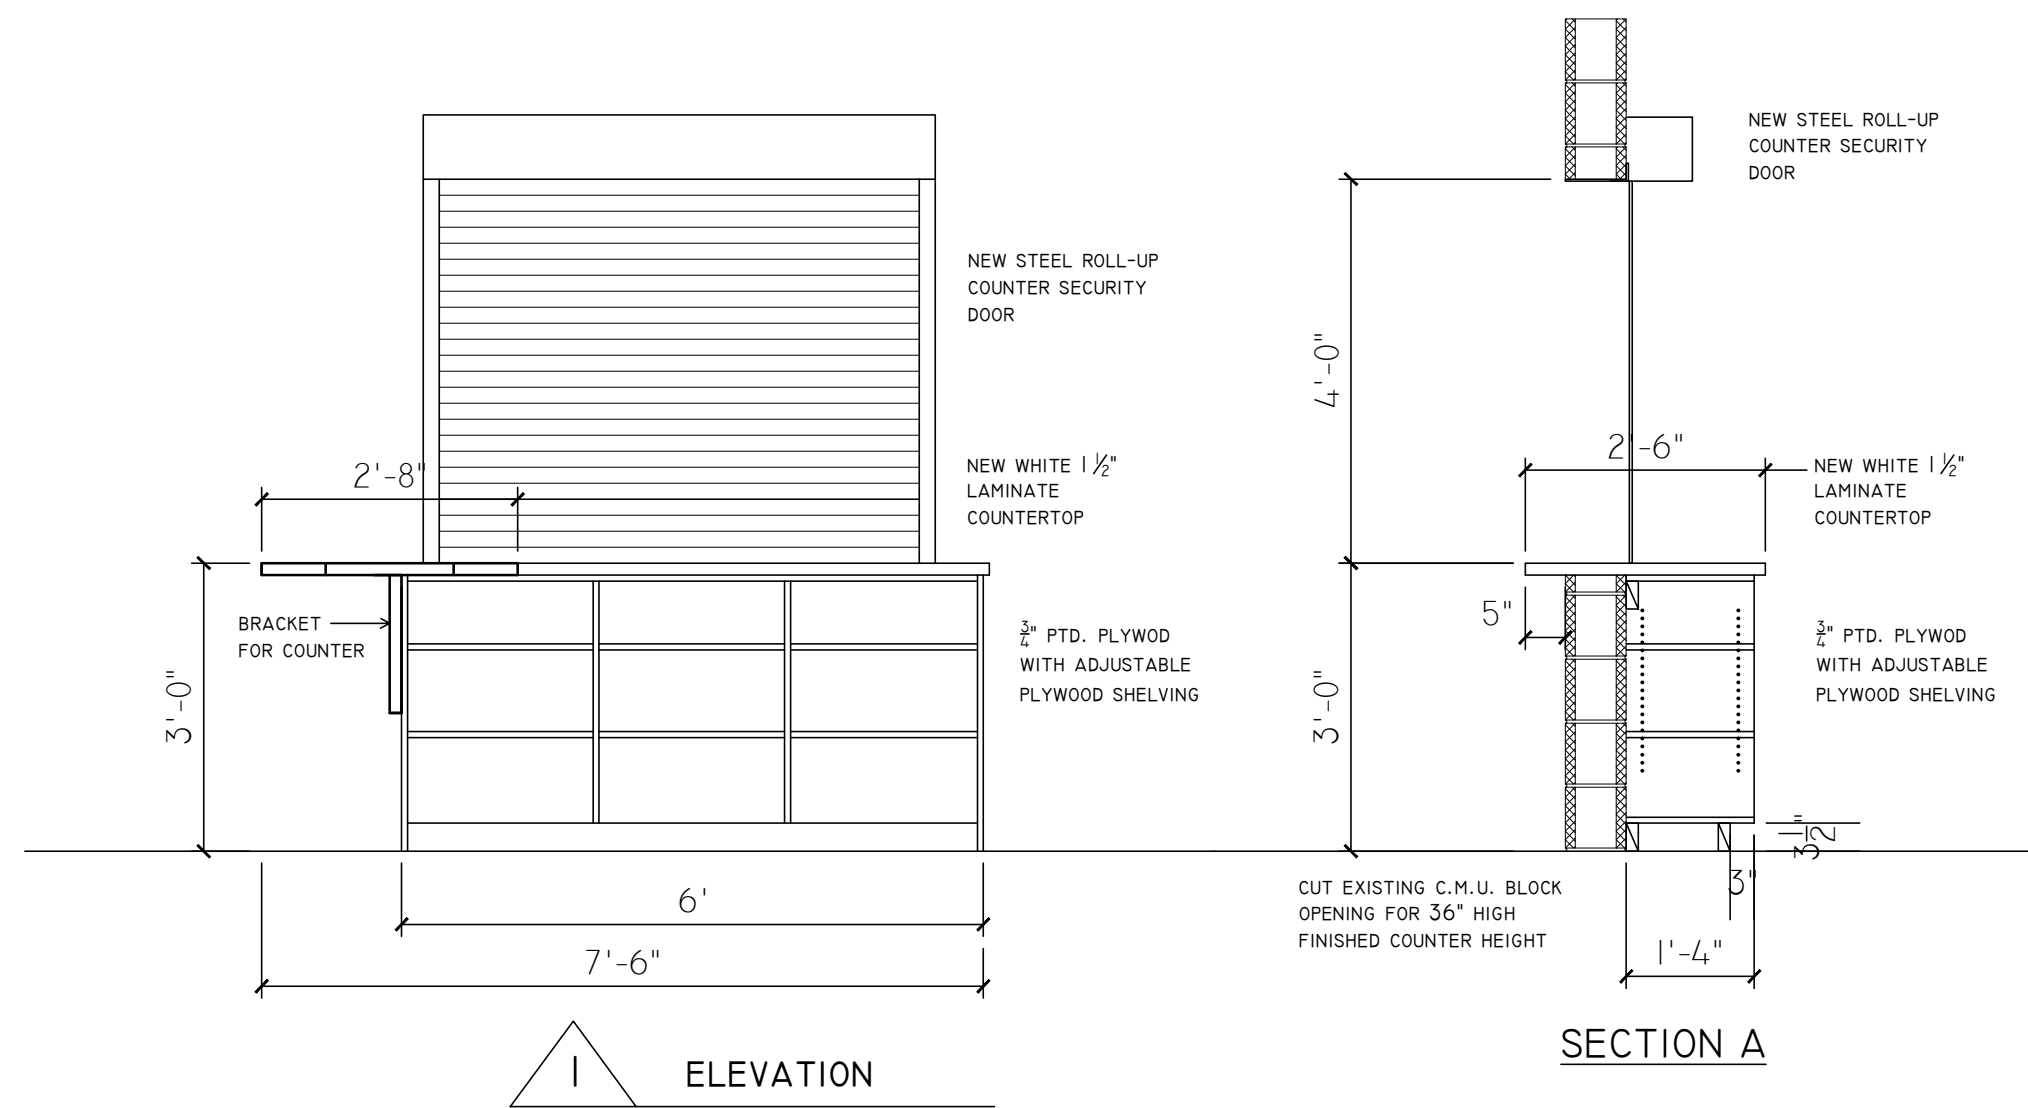


B **CONCESSION COUNTER & SHELVING**
SCALE: $\frac{1}{2}$ " = 1'-0"

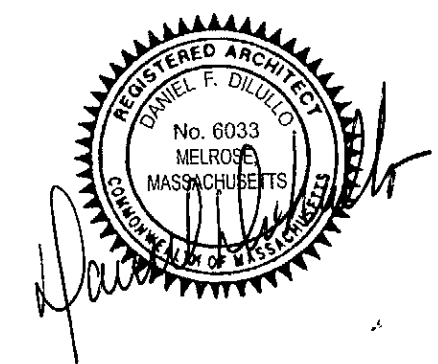

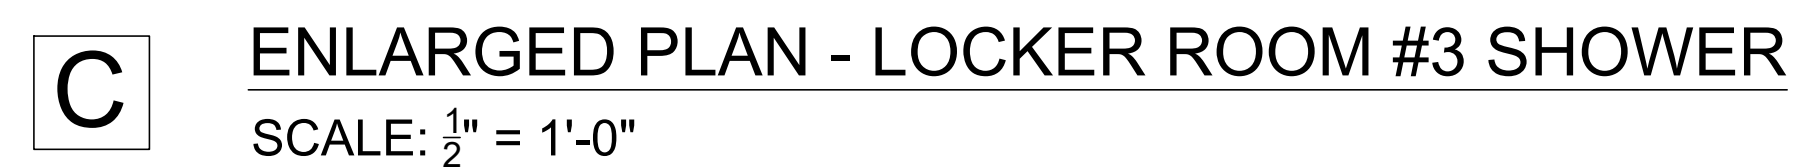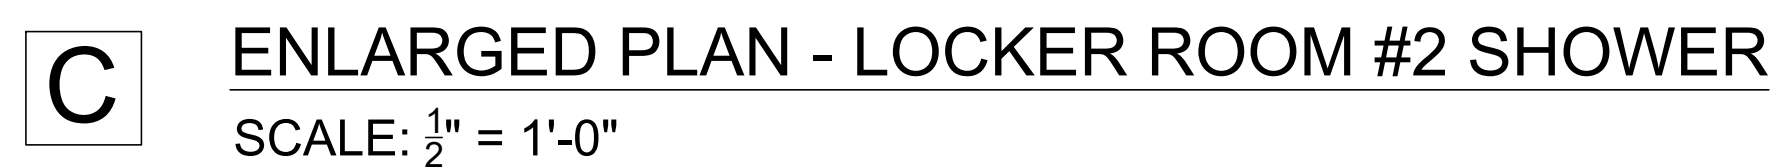


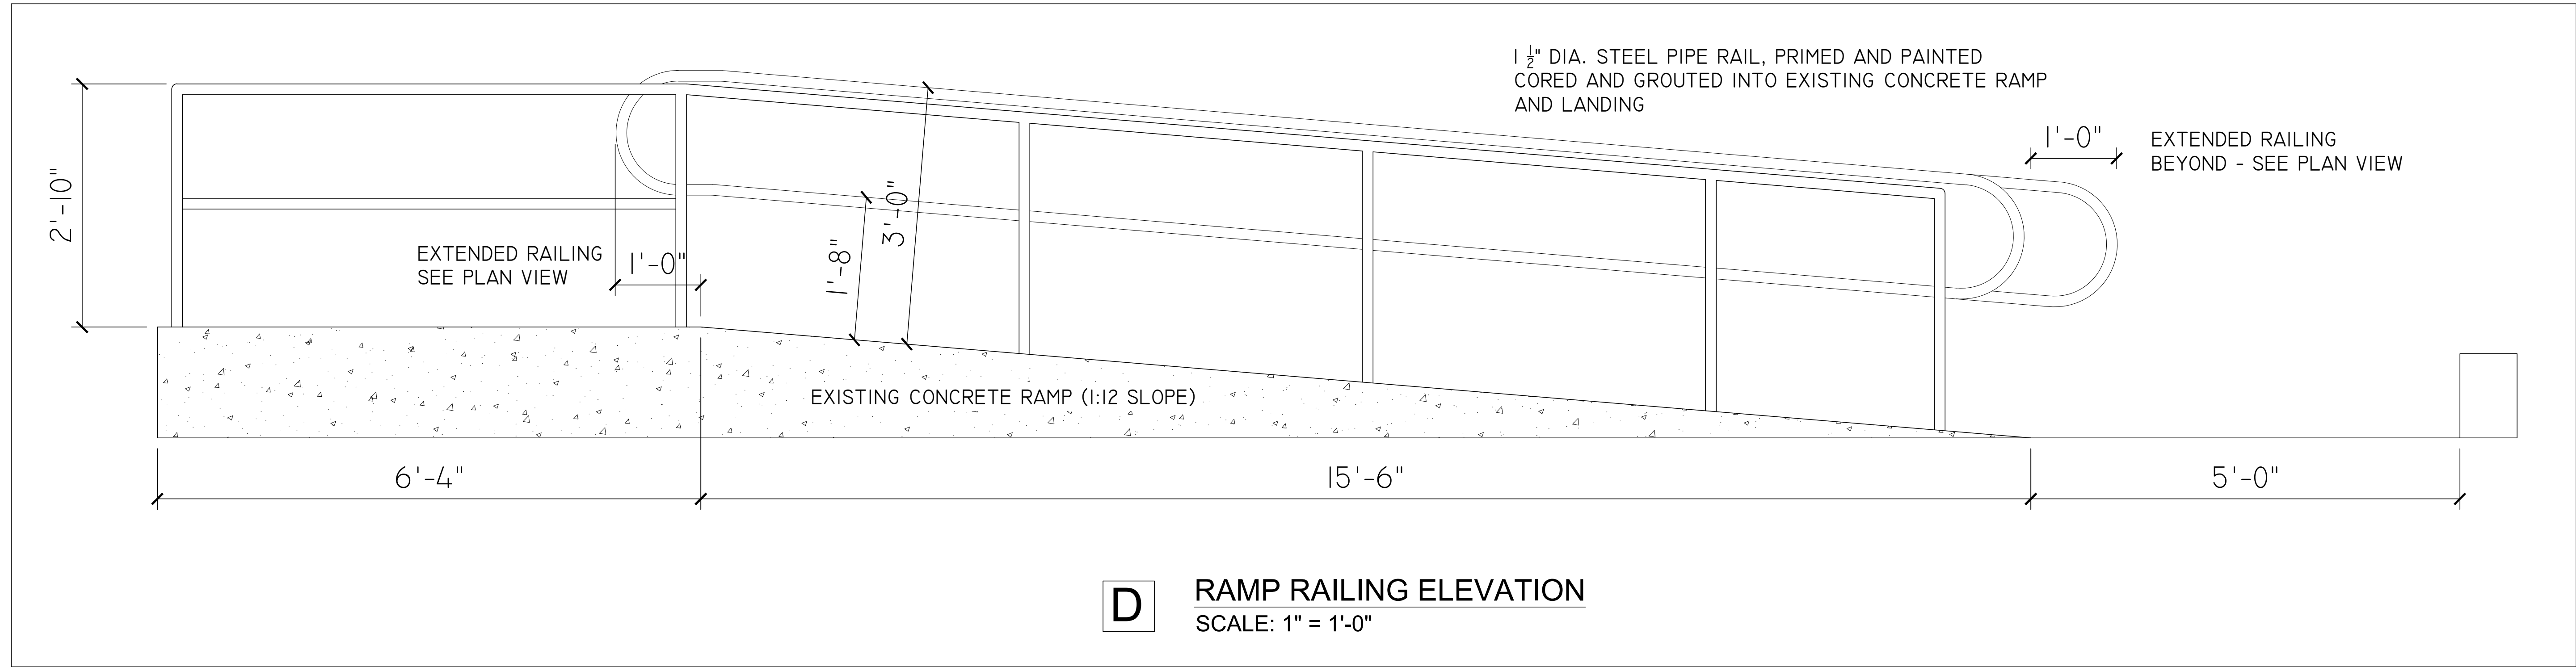

D RAMP RAILING ELEVATION
SCALE: 1" = 1'-0"

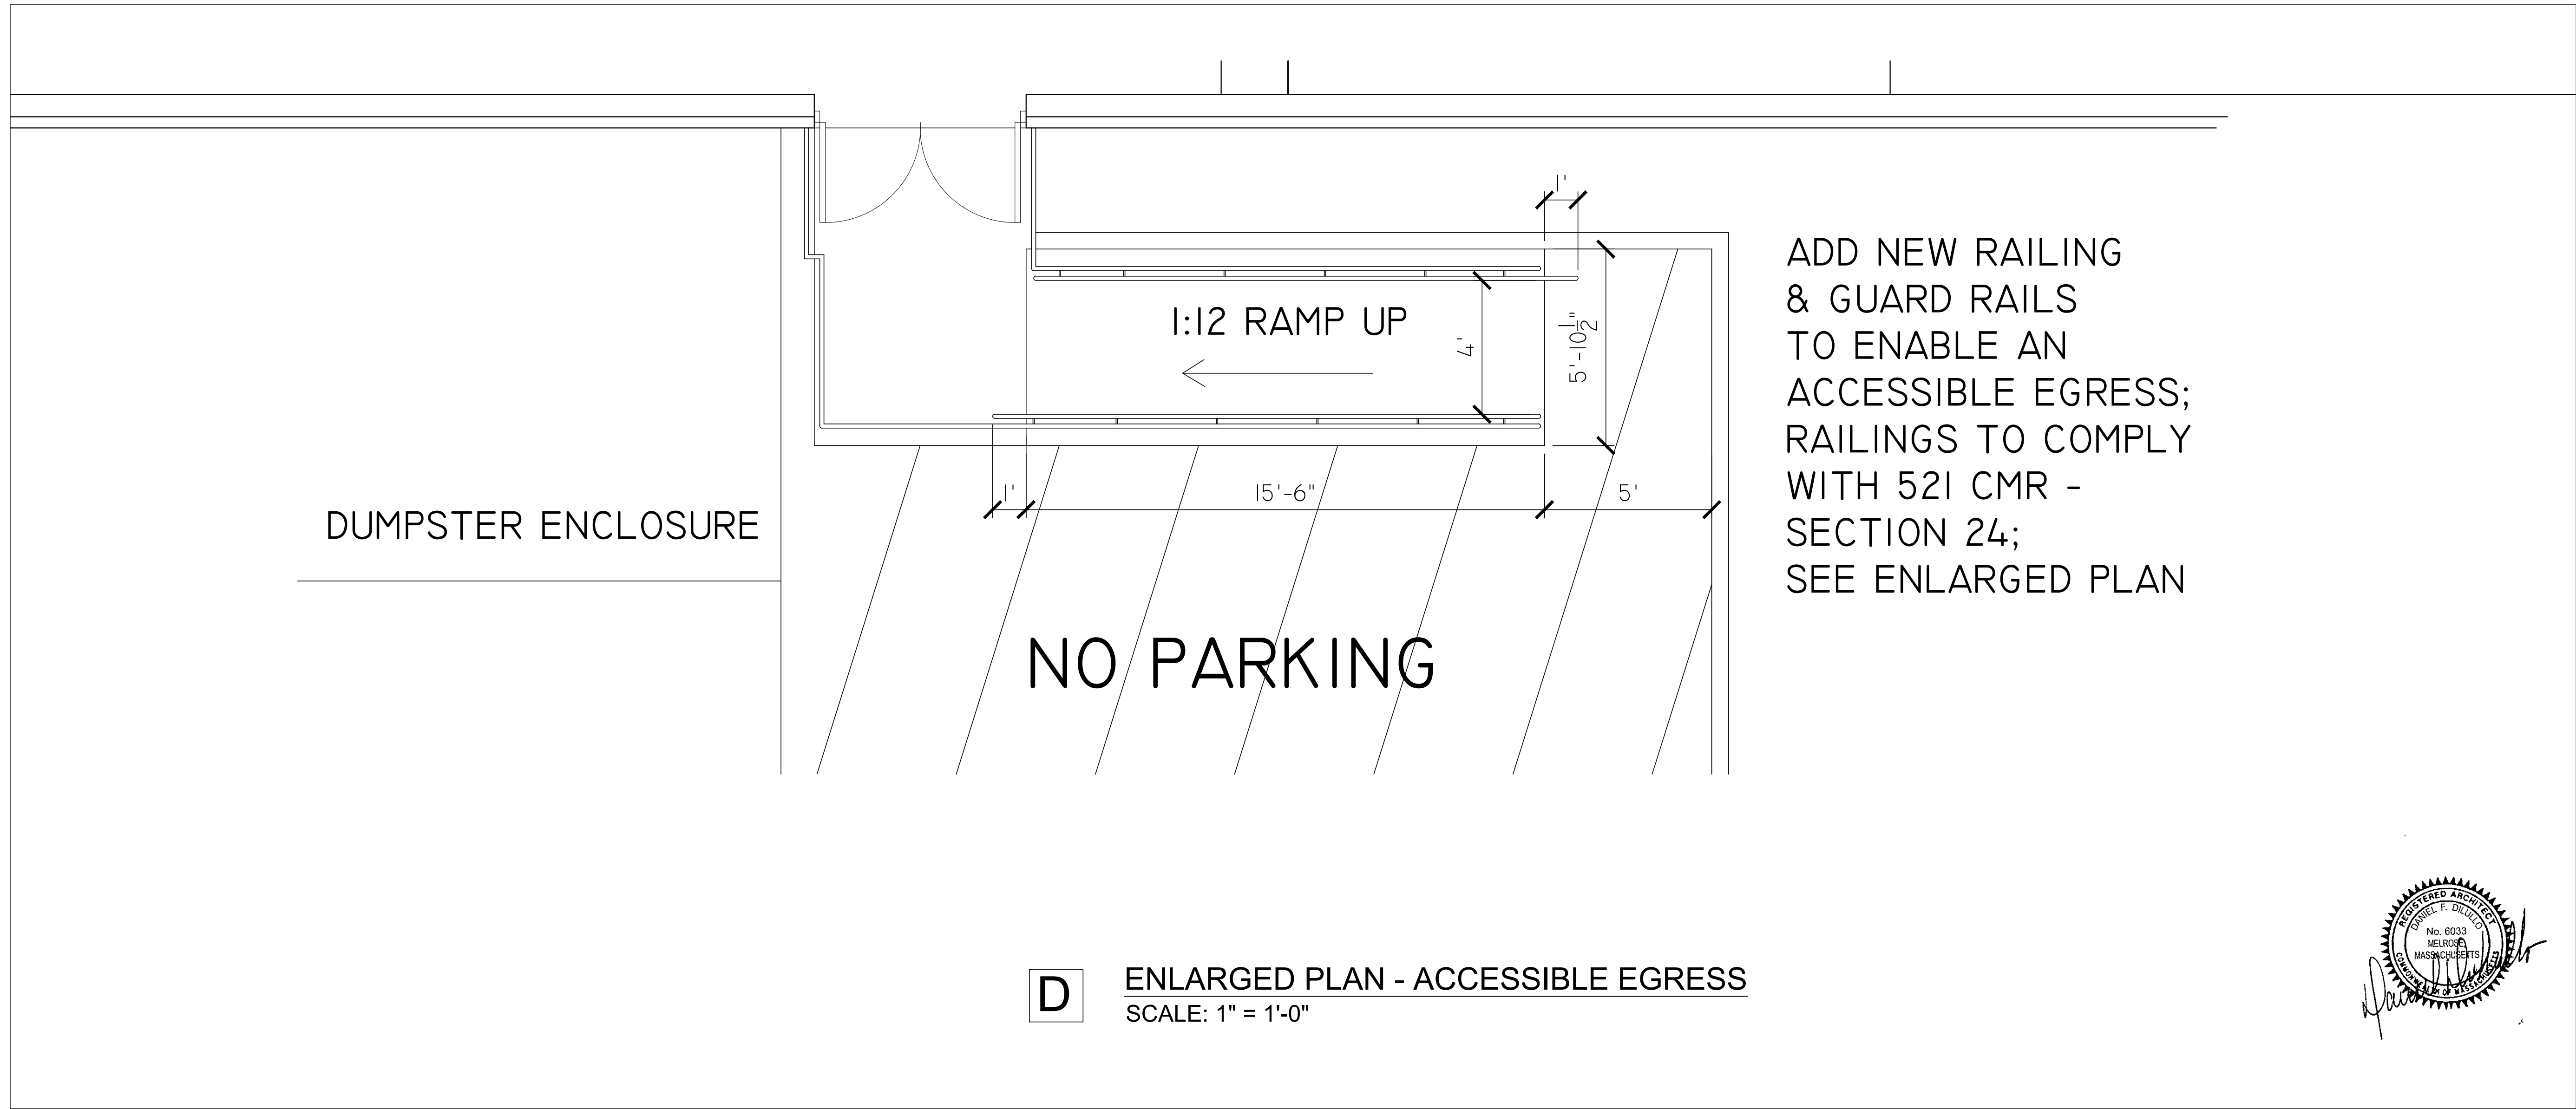

D ENLARGED PLAN - ACCESSIBLE EGRESS
SCALE: 1" = 1'-0"

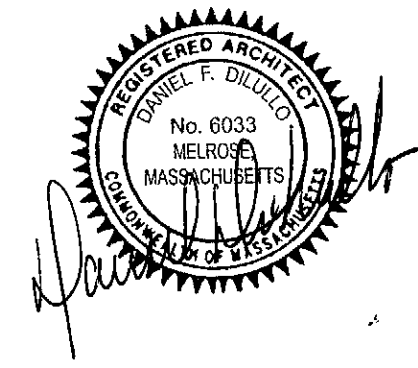

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drawn: JPL scale: AS NOTED date: 6/24/19

dwg no: **A1.4**

BUILDING
FACILITIES
ENGINEERING
COMPANY


100 Cummings Center Suite 235E
Beverly, Massachusetts 01915
Tel: (978) 927-3900
Fax: (978) 927-0239
www.bldgfac.com

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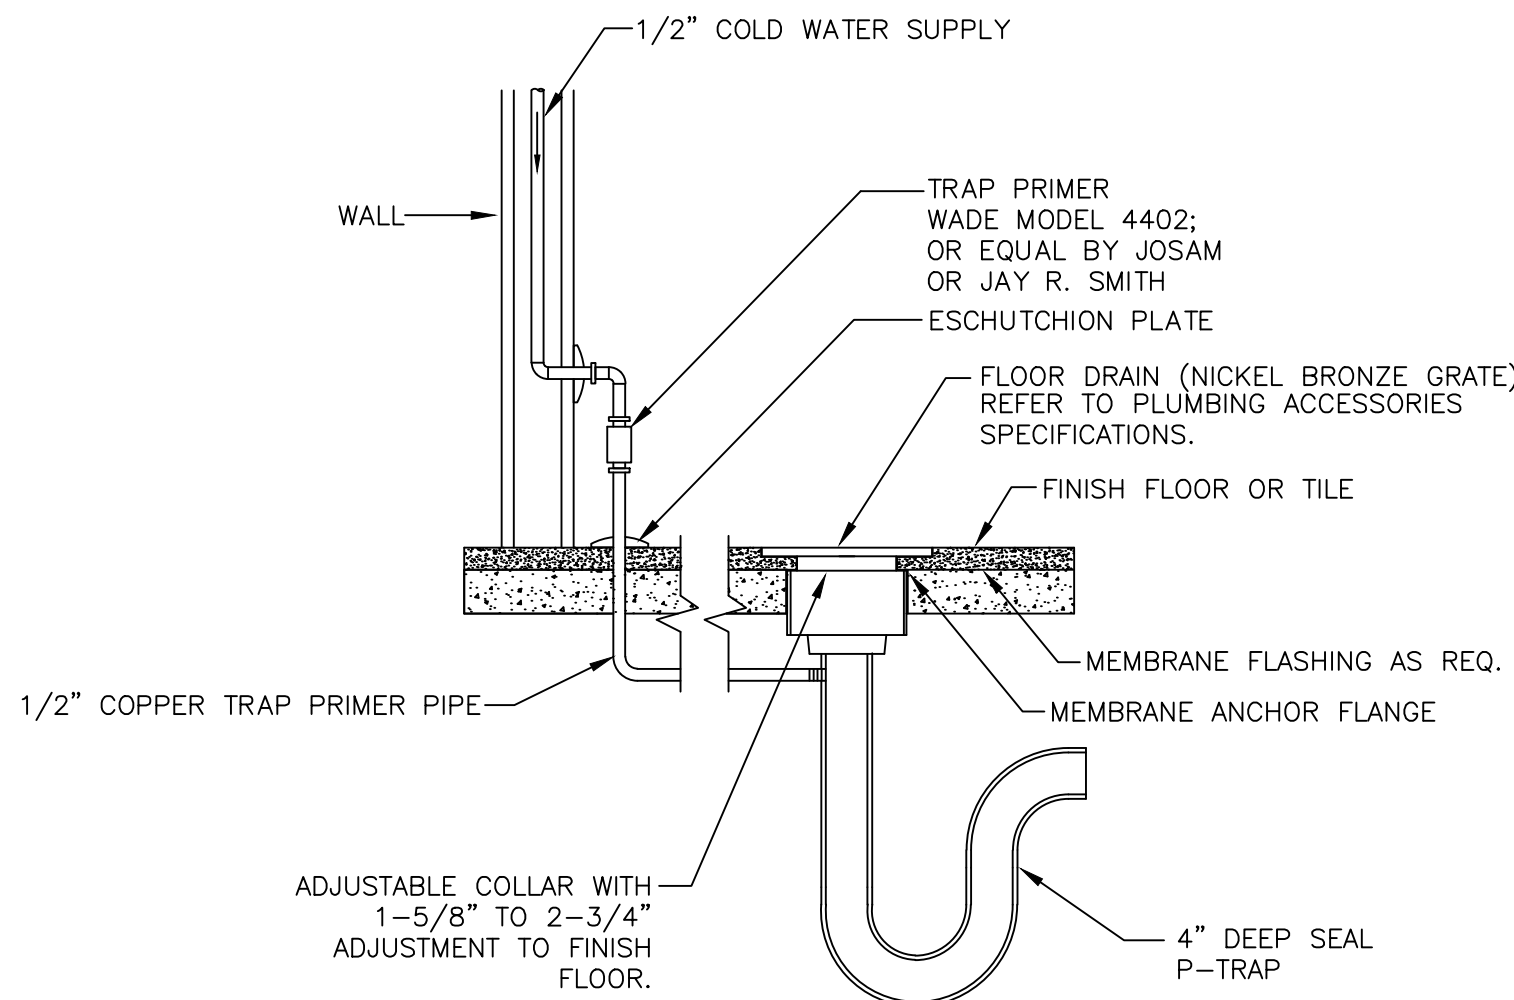
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GENERAL NOTES:

- ALL PLUMBING WORK SHALL CONFORM TO THE MASSACHUSETTS STATE PLUMBING CODE.
- ALL PIPING SHOWN IS DIAGRAMMATIC, EXACT LOCATION TO BE DETERMINED IN THE FIELD.
- ALL SANITARY & VENT PIPING 3" AND SMALLER SHALL PITCH 1/4" PER FOOT, UNLESS OTHERWISE SPECIFIED. ALL SANITARY AND VENT PIPING 4" AND LARGER SHALL PITCH 1/8" PER FOOT, UNLESS OTHERWISE SPECIFIED.
- THE PLUMBING SUBCONTRACTOR, BEFORE SUBMITTING HIS PRICE OR BEGINNING WORK, SHALL THOROUGHLY EXAMINE THE SITE AND CONTRACT DOCUMENTS, NO CLAIM FOR EXTRA COMPENSATION WILL BE ALLOWED IF DIFFICULTIES WHICH AN EXAMINATION OF SITE CONDITIONS AND/OR THE CONTRACT DOCUMENTS PRIOR TO EXECUTING CONTRACT WOULD HAVE REVEALED.
- THE PLUMBING CONTRACTOR SHALL MAINTAIN AT THE JOB AT ALL TIMES, A COMPLETE AND SEPARATE SET OF BLACK-LINE PRINT OF THE PLUMBING DRAWINGS WHICH HE SHALL MARK CLEARLY, NEATLY, AND ACCURATELY THE PROGRESS OF HIS WORK. MYLAR REPRODUCIBLE "AS BUILT" SHALL BE FURNISHED TO THE OWNER WHEN THE JOB IS COMPLETED AND BEFORE FINAL PAYMENT. MARKUPS SHALL BE TRANSFERRED TO A COMPUTERIZED AUTOCAD FILE BY HIS DRAFT PERSON.
- ANY AND ALL PERMITS REQUIRED FOR INSTALLATION OF ANY MATERIAL SHALL BE AS PART OF THE SPECIFICATION, INCLUDING ALL FEE'S OR EXPENSES INCURRED.
- ALL EQUIPMENT NECESSARY TO DO ALL TESTING AS REQUIRED BY THE SPECIFICATIONS AND/OR STATE CODE SHALL BE FURNISHED BY THIS PLUMBING CONTRACTOR.
- UPON COMPLETION OF ALL WORK, FURNISH IN DUPLICATE, CERTIFICATIONS OF INSPECTIONS FROM THE MANUFACTURERS STATING THAT AUTHORIZED FACTORY ENGINEERS HAVE INSPECTED AND TESTED THE OPERATION OF THEIR RESPECTIVE EQUIPMENT AND FOUND SAME TO BE IN SATISFACTORY OPERATING CONDITION.
- ALL EQUIPMENT AND PIPING SHALL BE GUARANTEED FOR A PERIOD OF ONE YEAR FROM THE DATE THE OWNER ACCEPTS THE BUILDING. IF THERE WERE ANY FAILURES DURING THE TIME FRAME WORK WAS PERFORMED, THEY SHALL BE REPAIRED AND/OR REPLACED AT NO CHARGE TO THE OWNER, OR ENGINEER.
- ALL VALVES AND CLEANOUTS SHALL BE PROVIDED WITH ACCESSIBLE WALL ACCESS PANELS IF REQUIRED.
- ALL HOT AND COLD WATER PIPING SHALL BE TYPE "L" COPPER TUBING WITH CAST BRASS FITTINGS.
- SOIL, WASTE, VENT AND DRAIN PIPING UNDER FLOOR SLAB (BURIED) SHALL BE SERVICE WEIGHT CAST IRON SOIL PIPE AND FITTINGS WITH RESILIENT GASKETS AND SHALL BE IN ACCORDANCE WITH CAST IRON SOIL PIPE INSTITUTE (CISPI)
- SOIL, WASTE, VENT AND DRAIN PIPING ABOVE FLOOR SLAB SHALL BE HUB-LESS CAST IRON PIPE AND FITTING WITH STAINLESS STEEL FITTING CLAMPS AND SHALL BE IN ACCORDANCE WITH CAST IRON SOIL PIPE INSTITUTE (CISPI)
- INSULATE ALL HOT AND COLD WATER PIPING WITH OWENS-CORNING OR APPROVED EQUAL 1" FIBER-GLASS SECTIONAL PIPE COVERING. FITTINGS TO BE INSULATED WITH "ZESTON" PRE-MOULDED FIBER-GLASS FITTING INSULATION.



FLOOR DRAIN W/ TRAP PRIMER DETAIL
NOT TO SCALE

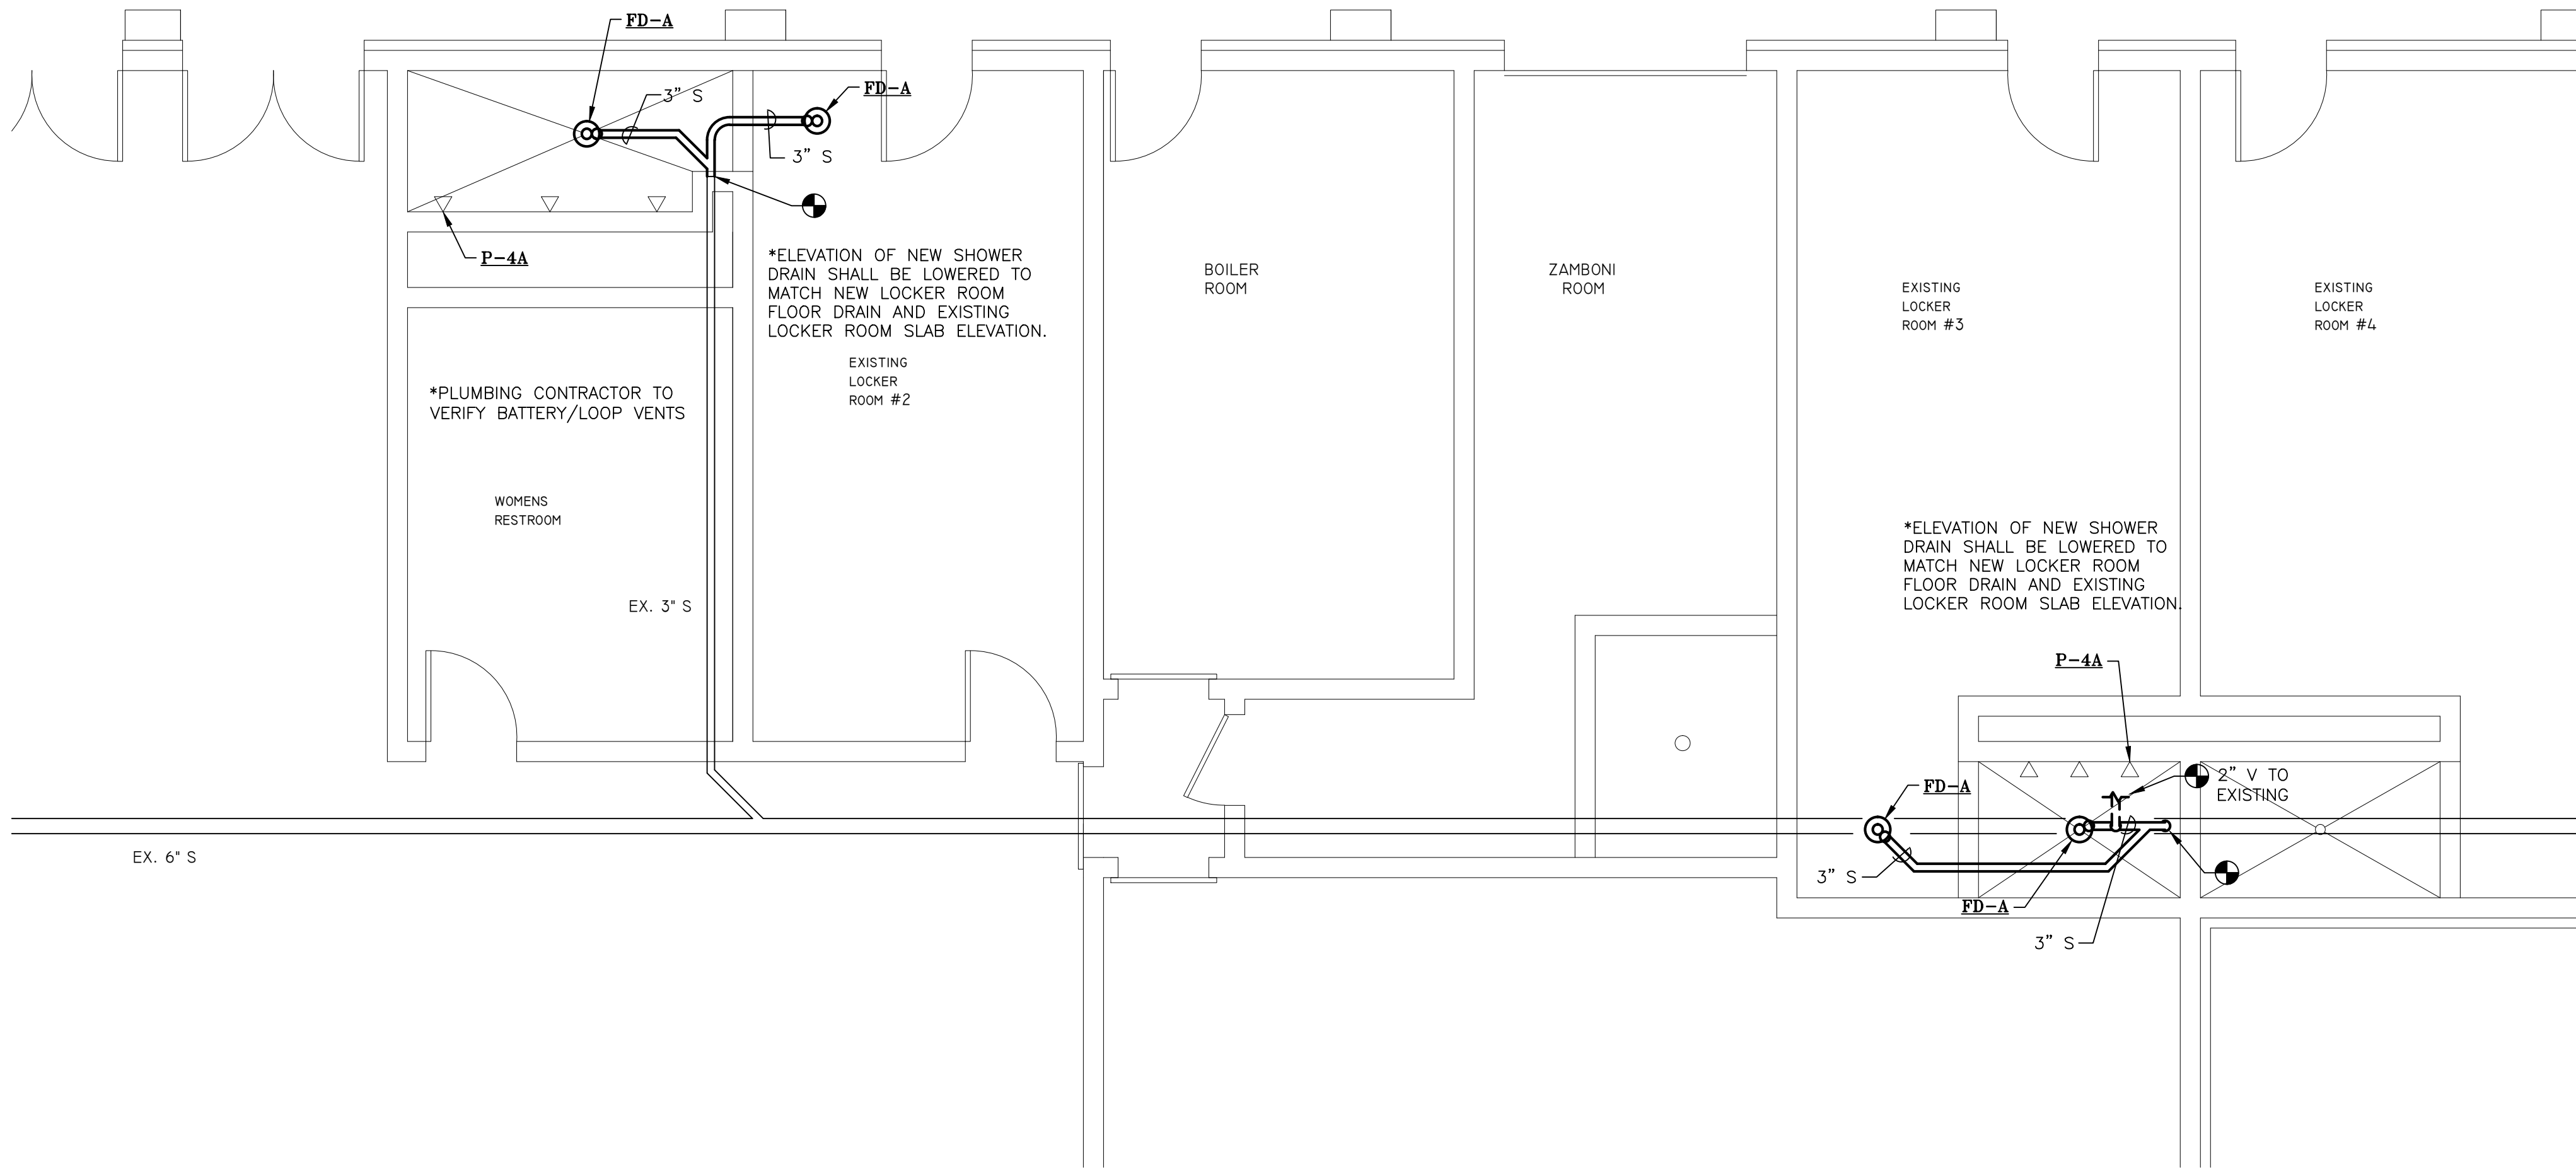FIXTURE SCHEDULE

TAG	FIXTURE TYPE	CONNECTIONS – INCHES				MAKE AND MODEL NO.
		SAN	VENT	HOT	COLD	
P-4A	SHOWER	3	2	1/2	1/2	EQUAL TO SYMMONS "ORIGIN" # T36-1.5 ADA HAND SHOWER SYSTEM OR EQUIVALENTS. BY AMERICAN STANDARD OR KOHLER. SHALL BE COMPLETE WITH IN-LINE VACUUM BREAKER, 60" FLEXIBLE METAL HOSE, MOUNTING BRACKET AND CONNECT TRAP WITH FEMALE ADAPTER, NO DESANCO'S ALLOWED. SHOWER GRAB BAR & SEAT PACKAGE BY OTHER.
FD-A	FLOOR DRAIN	3	2			EQUAL TO J.R. SMITH # 2005-A FLOOR DRAIN W/ NICKEL BRONZE ROUND TOP AND TRAP PRIMER.

LEGEND

-----	V	VENT BELOW GROUND	TYP.	TYPICAL
=====	S	SANITARY WASTE BELOW GROUND	FD-A	FLOOR DRAIN
P-1		PLUMBING FIXTURE	EX.	EXISTING
DN		DOWN		



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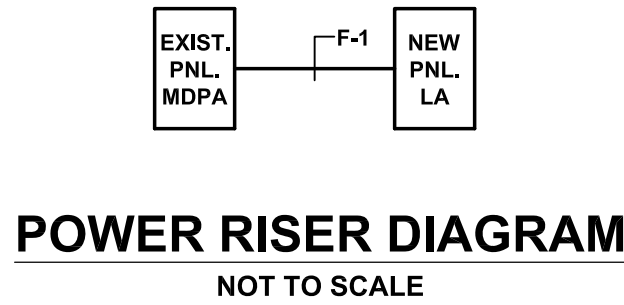
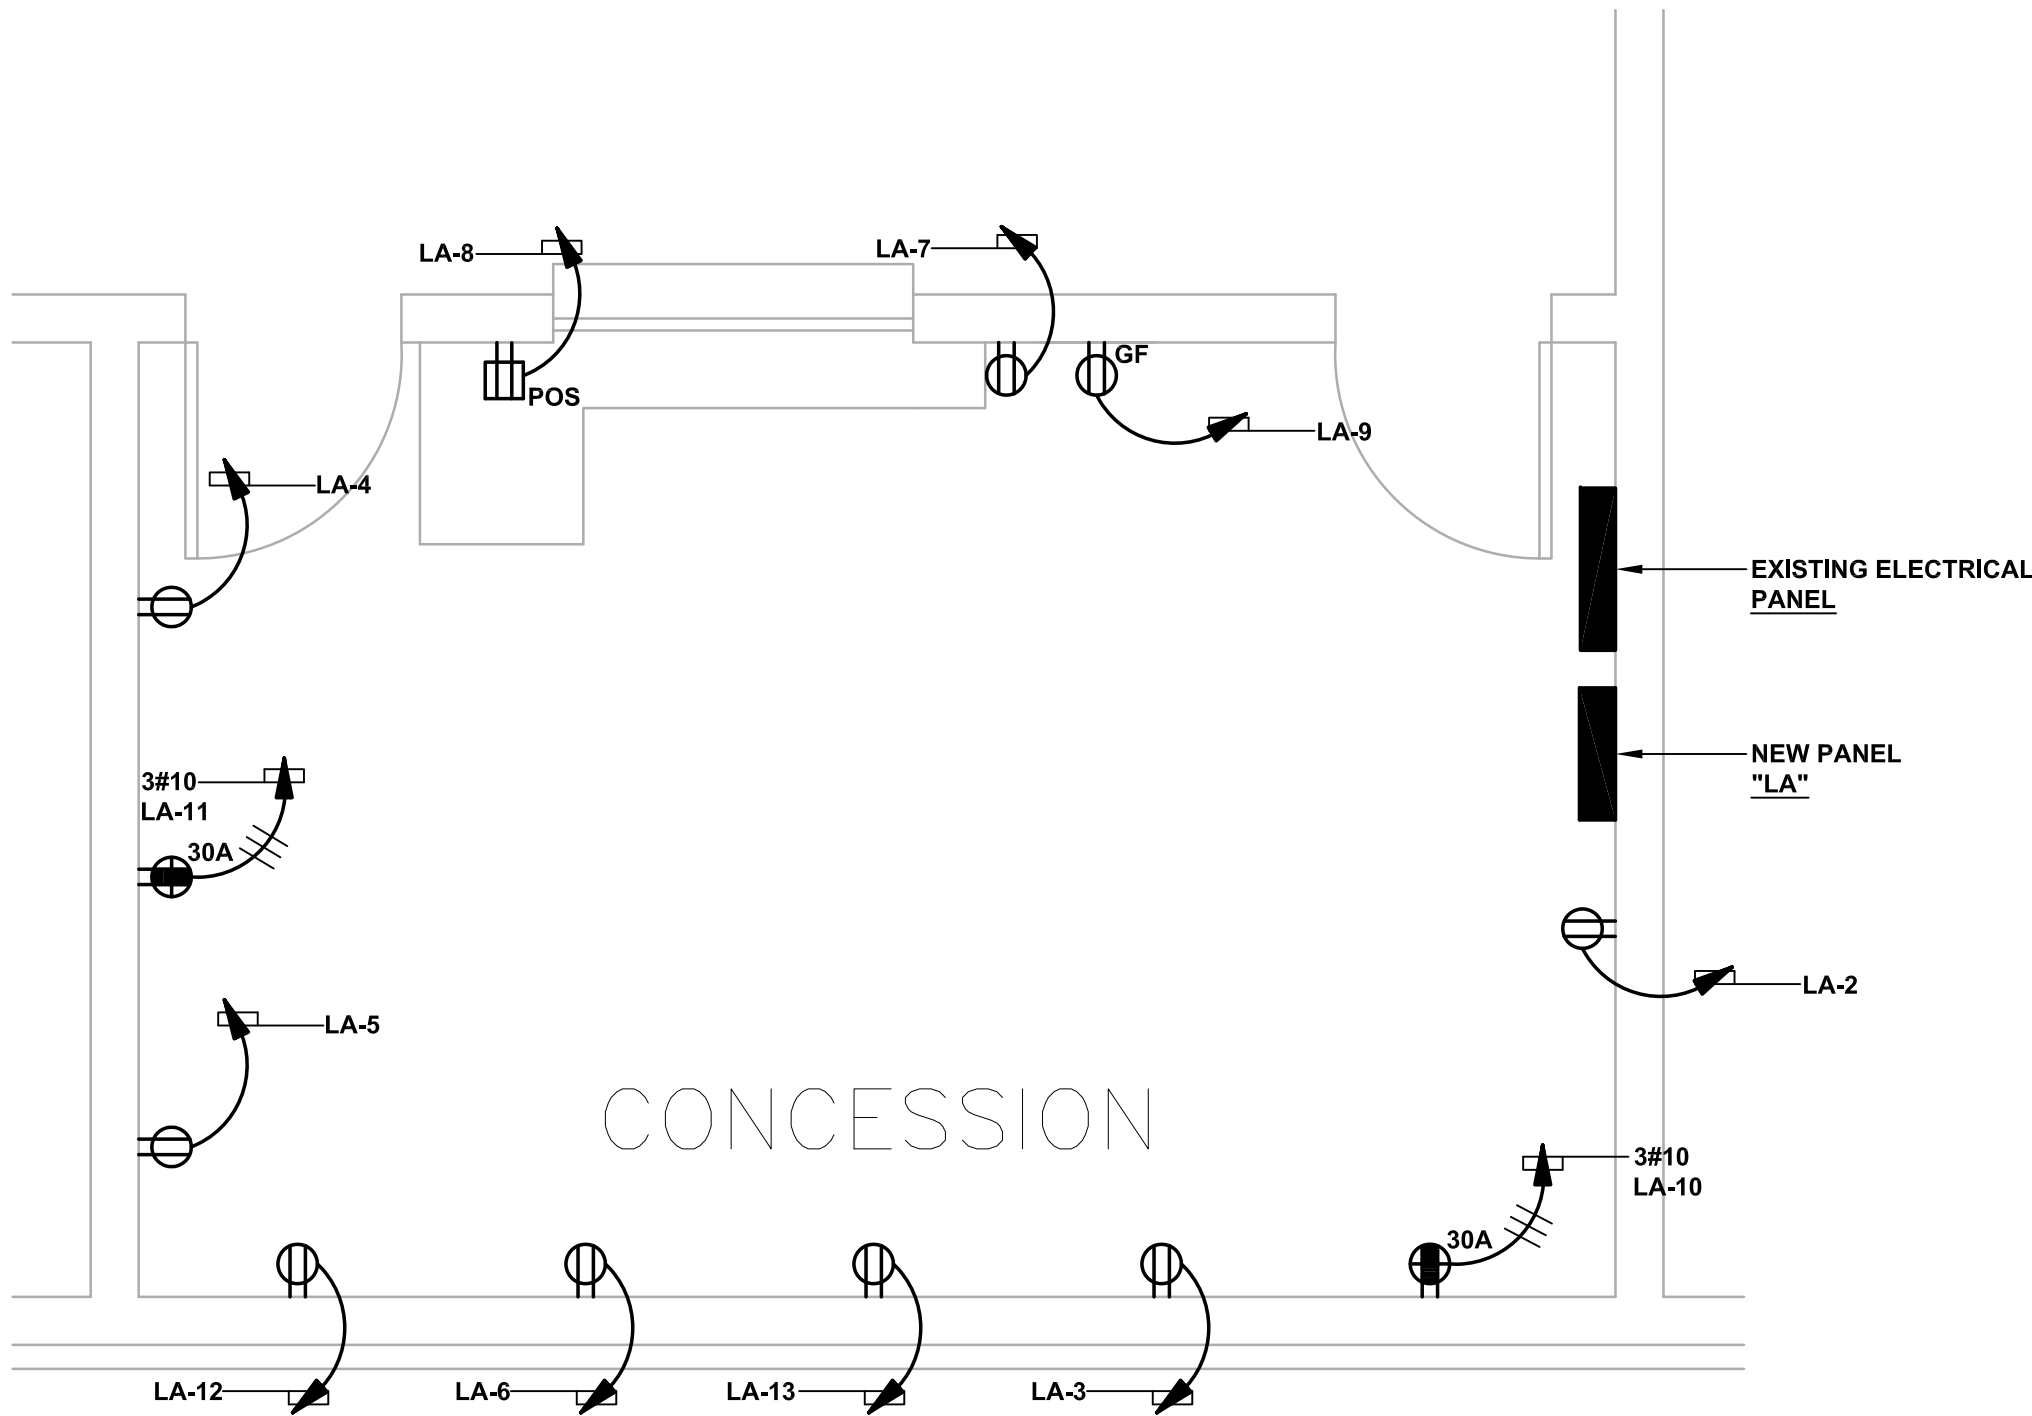
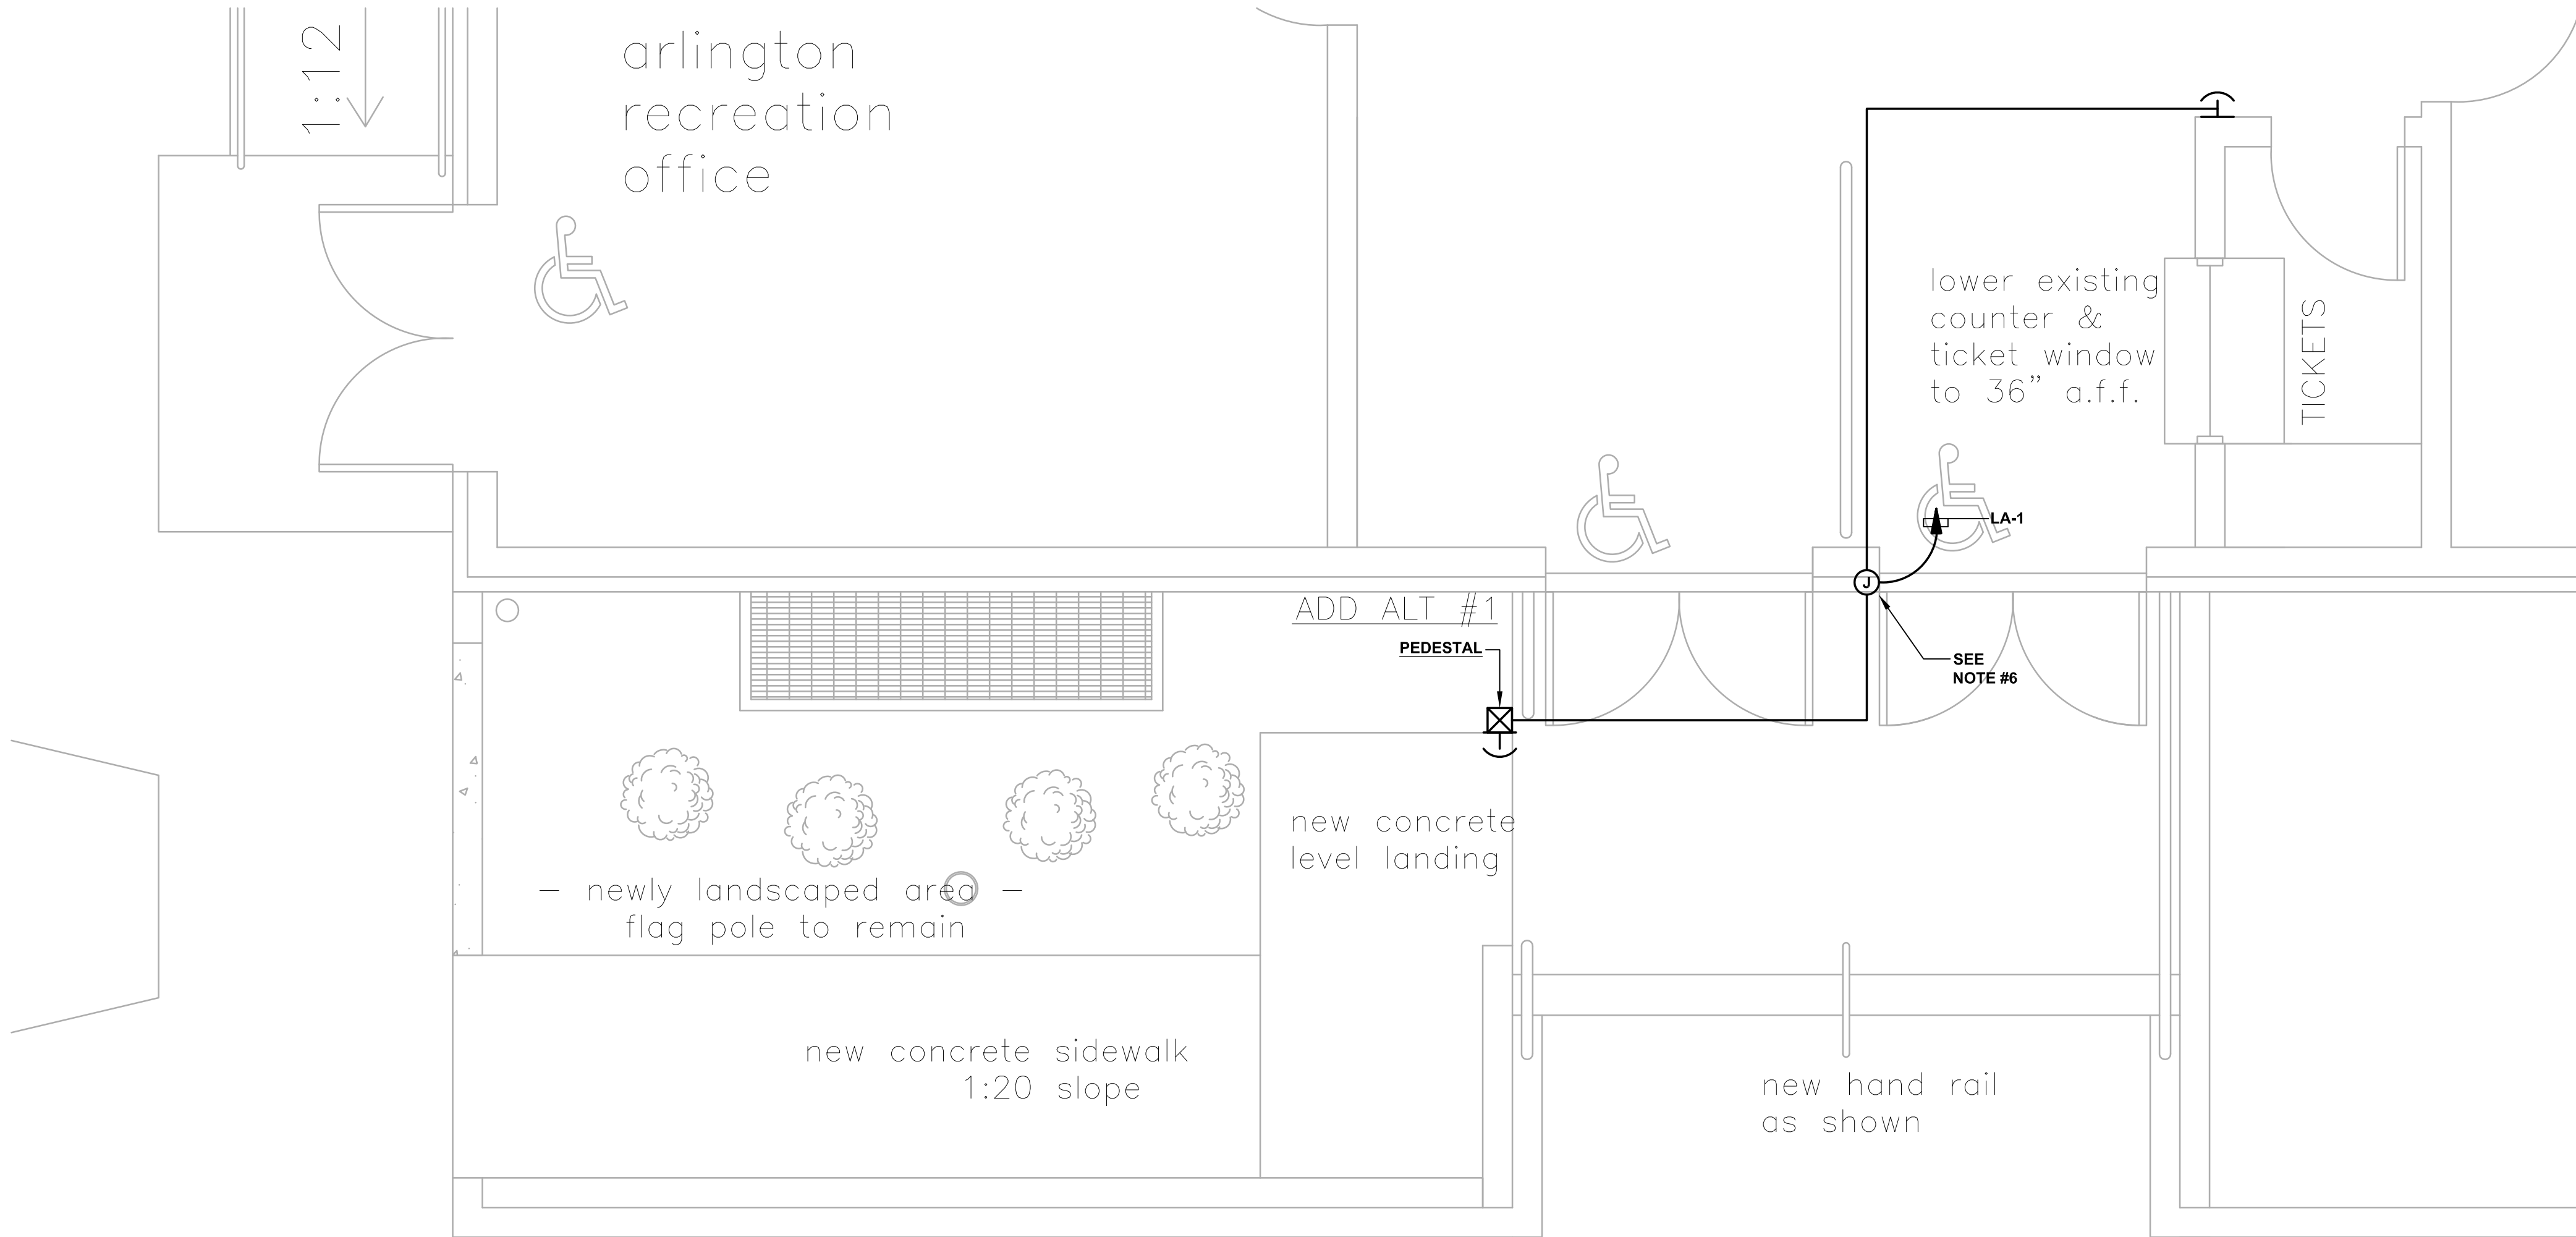
drawing title:

PLUMBING LOCKER
ROOMS #1 AND #2
PART PLAN

drawn: ST scale: 1/4" = 1'-0" date: 5/02/19

P1.1

dwg no:



LEGEND

- HOMERUN. ARROWS DENOTES THE NUMBER OF CIRCUITS AND SLASH MARKS DENOTE THE NUMBER OF #12 CONDUCTORS IN RACEWAY OR CABLE ASSEMBLY.
- JUNCTION BOX.
- PEDESTAL.
- PUSH BUTTON.
- DUPLEX RECEPTACLE (125 VOLT-1Ø3W RECEPTACLE, MOUNTED 18" A.F.F.).
- 125/2Ø8 VOLT - 1Ø RECEPTACLE. NUMERAL DENOTES THE AMPERE RATING OF THE RECEPTACLE.
- QUADPLEX RECEPTACLE.

- NOTES:**
- THE ELECTRICAL CONTRACTOR SHALL FURNISH AND INSTALL A NEW 125 AMPERE - 3 POLE CIRCUIT BREAKER IN EXISTING PANEL "MDPA" FOR NEW PANEL "CES".
 - NEW FEEDER F-1 SHALL BE #1, 1#6(G), 1-1/2" CONDUIT.
 - THE ELECTRICAL CONTRACTOR SHALL REMOVE EXISTING FEEDER SERVING THE EXISTING CONCESSION AREA.
 - THE ELECTRICAL CONTRACTOR SHALL TAP THE EXISTING PANEL "MDPA" WITH A 125 AMPERE-3 POLE CIRCUIT BREAKER FOR NEW PANEL "LA" FEEDER.
 - THE ELECTRICAL CONTRACTOR SHALL MODIFY THE EXISTING RECEPTACLES ON EXISTING PANEL TO PREVENT OVERLOAD CONDITION ON EXISTING RECEPTACLES IN CONCESSION ROOM.
 - AUTOMATIC DOOR CONTROL ELECTRICAL WORK SHALL BE PERFORMED UNDER ALTERNATE #1.
 - THE FINAL LOCATION OF ELECTRICAL OUTLETS IN THE CONCESSION ROOM SHALL BE DETERMINED BY THE ARCHITECT, ELECTRICAL CONTRACTOR AND OWNER IN THE FIELD.
 - THE ELECTRICAL CONTRACTOR SHALL REMOVE EXISTING RECEPTACLES IN CONCESSION ROOM AND ASSOCIATED BRANCH CIRCUIT WIRING AND INSTALL NEW RECEPTACLES IN CONCESSION ROOM AS INDICATED ON THE PLANS.

PANEL SCHEDULE

CIRCUIT NUMBER	BREAKERS			EQUIPMENT SERVED
	AMPS	POLES	AIC	
PANEL "LA" 120/2Ø8V, 3Ø4W, 225 AMPERE MAIN LUGS, SURFACE MOUNTED.				
1	20	1	10,000	DOOR CONTROLS
2-9	20	1	10,000	RECEPTACLES
10-13	30	2	10,000	RECEPTACLES
14-22	20	1	10,000	SPARES

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**ENLARGED
ELECTRICAL PLAN**

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E1.0

dwg no: